

Schenectady County Purchasing Department

620 State St.-2nd Floor Schenectady, NY 12305 <u>purchasing@schenectadycountyny.gov</u> 518.388.4240

ADDENDUM

RFB-2024-50 797 BROADWAY 1ST-3RD FLOORS INTERIOR RENOVATIONS C2 DESIGN GROUP

ADDENDUM #2

Issued Date: 08/15/2024

The purpose of this addendum is to provide detailed information to all Bidders. This addendum is hereby included in and made part of the Contract Documents, whether or not attached thereto. Receipt of this Addendum must be acknowledged on the bid form.

CONTENTS/RESPONSE TO QUESTIONS/REFERENCE TO ATTACHMENTS

General:

- 1. This addendum changes the documents for Bid #RFB-2024-50.
- 2. 01 15 00 Project Master Schedule
 - a. Revised Bid Due/Opening date to Thursday August 22nd 2024 at 2:00 pm.
 - b. Submission of Bid Questions to Wednesday August 14th, 2024 at 2:00 pm.
- 3. Secondary Pre-Bid Walkthrough Date: Monday August 19th, 2024 at 2:00 pm.

Attachments:

- 1. Drawings associated to Construction Phasing Plans
 - a. Revised Drawing list G101 Sheet List, Abbreviations and Symbols
 - b. G103 First Floor Construction Phasing Plan and Notes
 - c. G104 Second Floor Construction Phasing Plan and Notes
 - d. G105 Third Floor Construction Phasing Plan and Notes

- 2. Revised/New Contract Drawings and Specifications
 - a. Specification 087100 Door Hardware
 - i. Hardware Group Number 02 for use on Door 102
- 3. New Contract Specification TURF-WALL Panel
 - a. Specification 09 84 00 Sound-Absorbing Panels

Bid Request for Information and Response:

- 1. Provide existing building Deck heights.
 - a. Response:
 - i. 1st Floor Elevation 0'-0"
 - ii. 2nd Floor Elevation 13'-1" +/-
 - iii. 3rd Floor Elevation 26'-8" +/-
- 2. Door 101 to be Aluminum or Hollow Metal?
 - a. Response: Hollow Metal
- 3. Who installs Metal Support for Operable Partition?
 - a. Response: The G.C. provides and installs all supports associated to the Operable Partition.
- 4. Please confirm construction team can use elevators for deliveries?
 - a. Response: Yes, the contractor must coordinate dates and hours for use with the County.
- 5. Confirm if bathrooms are supposed to receive new tile backer after demolition?
 - a. Response: Yes, confirmed.
- 6. Provide track/stud gauge for 3 5/8" and 6" CFMF at exterior openings?
 - a. Response: 20 GA for both.
- 7. Are there window treatments for this project?
 - a. Response: No.
- 8. Door 101 to be Aluminum or Hollow Metal?

- a. Response: Hollow Metal
- 9. The door schedule on Drawing A900 calls for opening 102 to be a hollow metal door with an aluminum finish. Should this be a hollow metal door with a painted finish or an aluminum door with aluminum finish?
 - a. Response: Revise A900 Door Schedule, Door 102 Material to read ALUM (Aluminum) with Anodized Aluminum finish (See Specifications).
- 10. The door schedule on Drawing A900 does not provide frame details for opening 102. Is the frame existing to remain or should a frame be provided?
 - a. Response: Existing frame to remain.
- 11. clarify the WC-1 in corridors 114,124, and 126. We have no elevations is it full height or partial please provide detail/ elevations.?

Response: Full height wallcoverings.

- 12. In various rooms that are getting new flooring (and floor patch) that have cubicles, is the County relocating them while we do our work, and all other furniture?
 - a. Response: The G.C. is responsible for temporary relocation and storage of all furniture as directed by the County. See phasing plans for order of work.
- 13. Drawing D100 Keynote D01 and D29 is this work by the GC or the MC prime?
 - a. Response: Work shall be completed by the G.C.
- 14. Drawing D100 Room 102 keynote D26 is this the correct keynote? Similar question for room 112 keynote 25?
 - a. Response: For room 102, ONLY keynotes D04 and D15. For room 112, The door should be keynote D21.
- 15. Drawing A100 Room 125 has keynote 115, but under the legend there is not keynote 115, please clarify?
 - a. Response: Keynote 115 to read: "EXISTING END GWB WALL TO REMAIN"
- 16. Drawing A100 Room 136 keynote 114 states acoustical wall panels provide blocking in wall, this is an existing wall. Are we to remove sheetrock install blocking and re-sheetrock wall? Please clarify? Similar question for room 107?
 - a. Response: Panels to mount with Z-clips and Z-Bars attached to existing studs
- 17. Drawing A600 the bathroom floor plans do not match the elevation for keynotes, for instance A600 is missing keynotes 606 and 608, please clarify which is correct?
 - a. Response: FOLLOW INTERIOR ELEVATIONS FOR KEYNOTES

- 18. Drawing A700 references both acoustical wall panels and film on window (detail 5/A700) neither do we have specification for?
 - a. Response:
 - i. FOR ACOUSTICAL PANELS, WE WILL INCLUDE SPECIFICATIONS
 - ii. FOR FROSTED VINYL FILM, MANUFACTURER TO BE AJ SIGNS
- 19. Drawing A900 door 102 shows in door schedule under material as HM, but the finish reference Alum., which is correct? We are to hang this door on an existing frame, correct?
 - a. Response: DOOR 102 TO BE ALUMINUM/GLAZED WITH ANODIZED ALUMINUM FINISH IN AN EXISTING FRAME
- 20. Drawing D100 has note D15 which states remove existing wall finishes, does this mean we are to remove the wall covering (paper)?

Response: Correct.

21. At the walk thru we notice many areas are note D04 we are to remove the flooring and base, my question is the areas that are carpeted is there VCT under the carpet?

Response: G.C. to verify.

- 22. The plans call for knockdown frames and the spec says welded. Please confirm.
 - a. Response: Knockdown frames as noted on drawings are acceptable.

Please acknowledge this addendum on your bid form.

END OF ADDENDUM #2

| ABBREVIATIONS | | | | | <u>SYMBOLS</u> |
|-----------------|---|-----------------|--------------------------------------|--|---|
| KEY NAME | <u>FULL NAME</u> | KEY NAME | FULL NAME | | WINDOW TAG: |
| A.B. | ANCHOR BOLT | O.A. | OVERALL | Â | REFERENCE WINDOW SCHEDULE ON A900 FOR |
| ABR. ACT | ABRASIVE FINISH ACOUSTICAL CEILING TILE | O.C. O.D. | ON CENTER OUTSIDE DIAMETER | • | SIZE AND DETAIL |
| ADH. | ADHESIVE | ОН | OVERHEAD | • | |
| ADJ. AFF | ADJUSTABLE ABOVE FINISH FLOOR | O.H. OPG. | OPPOSITE HAND OPENING | 1 | ELEVATION TAG: DRAWING NUMBER |
| ALUM. | ALUMINUM | PC | PIECE | A100 Ref | (TOP NUMBER) SHEET NUMBER |
| ALT. APPROX. | ALTERNATE APPROXIMATE | PCF PL | POUNDS PER CUBIC FT PLASTIC LAMINATE | Their | (BOTTOM NUMBER) |
| ARCH. B/ | ARCHITECT BOTTOM OF | PLAM PLT | PLASTIC LAMINATE PLATE | | |
| B/B | ВАСК ТО ВАСК | PLF | POUNDS PER LINEAR FT | | INTERIOR ELEVATION TAG: |
| BD. BLDG. | BOARD BUILDING | PLUMB. PLYWD | PLUMBING PLYWOOD | 1 1 | DRAWING NUMBER (TOP NUMBER) REFERENCE SPECIFIED SHEET |
| BLK | BLOCK | POLY | POLYETHYLENE | 1 × A100 | FOR DRAWING NUMBER |
| BM B.O. | BEAM BOTTOM OF | PR. PSF | PAIR POUNDS PER SQUARE FT | | |
| ВОТ. | BOTTOM | PSI | POUNDS PER SQUARE IN | (100) | DOOR TAG: REFERENCE DOOR |
| B.A. BR. | BEARING PLATE BRICK | PFT PT | PORCELAIN TILE PAINT | (100) | SCHEDULE ON A900 FOR SIZE AND DETAIL |
| BRG. CAB. | BEARING CABINET | PTD. Q.T. | PAINTED QUARRY TILE | | |
| CAB. CB | CATCH BASIN | R. | RISER | | |
| CDX. CF | C-D GRADE EXT. PLYWOOD CUBIC FEET | RAD. RB | RADIUS RUBBER BASE | | WALL TYPE TAG: RATING |
| C.H. | CABINET HEATER | R.D. | ROOF DRAIN | OA | REFERENCE WALL TYPES FOR WALL CONSTRUCTION |
| CIR. C.J. | CIRCUIT CONTROL JOINT | REF. REINF. | REFERENCE REINFORCING | | FOR WALL CONSTRUCTION |
| CL | CENTER LINE | REQ'D. | REQUIRED | | |
| CLG. CLR. | CEILING CLEAR | REV. RFL | REVISION RUBBER FLOOR | | ELEVATION MARKER: |
| CMU | CONCRETE MASONRY UNIT | R.L. | ROOF LEADER | T.O. SLAB 0' - 0" | SPECIFIES THE VERTICAL HEIGHT AT A GIVEN LOCATION |
| COL. CONC. | COLUMN CONCRETE | RM. RT. | ROOM RESILIENT TILE | 0-0 | |
| CONST. | CONSTRUCTION | R.V. | ROOF VENT | | DI AN DETAIL TAC. |
| CONT. CONTR. | CONTINUOUS CONTRACTOR | SCHED. SECT. | SCHEDULE SECTION | | PLAN DETAIL TAG: DRAWING NUMBER (TOP NUMBER) |
| COORD. | COORDINATE | SF | SQUARE FOOT | $\frac{1}{A101}$ SIM | REFERENCE SPECIFIED SHEET FOR DRAWING (BOTTOM NUMBER) |
| CORR. CPT | CORRUGATED CARPET | SHT. SIM. | SHEET SIMILAR | Olim | , |
| CRS. | COURSES | SPEC. | SPECIFICATIONS | | |
| CSK. CT | COUNTER SINK CERAMIC TILE | SQ. S.S. | SQUARE STAINLESS STEEL | | SECTION DETAIL TAG: |
| C.W. | COLD WATER | ST | STAIN | 1 | DRAWING NUMBER (TOP NUMBER) REFERENCE SPECIFIED SHEET FOR |
| DET DIA . | DETAIL DIAMETER | STD. STL. | STANDARD STEEL | A100 SIM | DRAWING (BOTTOM NUMBER) |
| DIAG. | DIAGONAL | STRUCT. | STRUCTURAL | • | |
| DIM. DR | DIMENSION DOOR | SUSP. T. | SUSPENDED TREAD | | |
| DWG | DRAWING(S) | T/ | TOP OF | | DEMOLITION TAG: |
| EA. E.F. | EACH EACH FACE | T&B T/C. | TOP AND BOTTOM TOP CHOR | X | REFERENCE PLANS AND |
| E.J. | EXPANSION JOINT | T/F | TOP FLANGE | V | GENERAL DEMOLITION NOTES |
| ELEC. ELEV. | ELECTRICAL ELEVATION | T/FTG T.O. | TOP OF FOOTING TOP OF | | EQUIPMENT TAG: |
| EQ | EQUAL | T.O. THK. | THICK | $\langle \chi \rangle$ | REFERENCE PLANS AND |
| EQUIP. ETR | EQUIPMENT EXISTING TO REMAIN | THRU. | THROUGH | V | EQUIPMENT SCHEDULES |
| EXIST. | EXISTING TO REMAIN EXISTING | TP. TRANS. | TOPPING TRANSVERSE | | |
| EXP. | EXPOSED EXTERIOR | TS. | TUBE STEE TOP OF SLAB | $\langle \chi \rangle$ | NOTE TAG: SEE ASSOCIATED LEGEND |
| EXT. F.D. | FLOOR DRAIN | T/S T/STL. | TOP OF STEEL | • | SEE AGGOGIATED EEGEND |
| F.C. | FAN COIL | TYP. | TYPICAL UNEXCAVATED | FD | ELOOP DRAIN (ED) |
| FDN. F.F. | FOUNDATION FINISH FLOOR | UNEX. UNO | UNLESS NOTED OTHERWISE | | FLOOR DRAIN (FD) |
| FIN. FLG. | FINISH FLANGE | VAR. VB | VARIES VINYL BASE | | |
| FLR. | FLOOR | V.B. | VAPOR BARRIER | (RD) | ROOF DRAIN (RD) |
| FT. GRP. | FEET GROUP | VCT VERT. | VINYL COMPOSITE TILE VERTICAL | | |
| GWB | GYPSUM WALL BOARD | V.I.F. | VERIFY IN FIELD | | EVICTING WALL TO DEMAIN TVD |
| GYP. H.B. | GYPSUM HOSE BIB | VTR W | VENT THRU ROOF WATER | | EXISTING WALL TO REMAIN, TYP. |
| HC | HANDICAP | W/ | WITH | | |
| HDW. HDWD | HARDWARE HARDWOOD | WB W.J. | WOOD BASE WATER CLOSET | | EVICTING WALL TO BE DEMOVED TVD |
| H.M. | HOLLOW METAL | WD | WOOD | | EXISTING WALL TO BE REMOVED, TYP. |
| HORIZ. H.P. | HORIZONTAL HIGH POINT | W.I. W.W.F. | WROUGHT IRON WELDED WIRE FABRIC | | |
| H.S. | HIGH STRENGTH | ****** | WEEDED WINE FABRIC | 7/////// | NEW STUD WALL CONSTRUCTION |
| HT. HVAC | HEIGHT HEAT, VENT AND AC | | | | |
| H.W. | HOT WATER | | | | |
| H.W.T. I.D. | HOT WATER TANK INSIDE DIAMETER | | | | NEW MASONRY WALL CONSTRUCTION |
| I.E. | INVERT ELEVATION | | | | NEW MASONRY WALL CONSTRUCTION |
| IN. | INCH(ES) | | | | |
| INSUL. INT. | INSULATION INTERIOR | | | | EVICTING DOOD |
| INV. | INVERT JANITOR | | | | EXISTING DOOR TO REMAIN, TYP. |
| JAN. JT. | JOINT | | | | |
| LAM. LAV. | LAMINATED LAVATORY | | | . 7 | |
| LAV. LLH. | LONGER LEG HORIZONTAL | | | / " / " | EXISTING DOOR TO |
| LLV. | LONGER LEG VERTICAL | | | . " / ! " | BE REMOVED, TYP. |
| LOC. LONG. | LOCATION LONGITUDINAL | | | | |
| L.P. | LOW POINT | | | ~~~ ~ | |
| M. MANUF. | METER MANUFACTURER | | | \\ \ \ \ \ \ \ \ \ \ \ \ \ \ \ \ \ \ \ | EXISTING FIXTURES |
| MAS. | MASONRY | | | (, L-1 | TO BE REMOVED |
| MAT. MAX. | MATERIAL MAXIMUM | | | `_ | |
| M.B. | MACHINE BOLTS | | | | |
| MC M.C. | METAL CHANNEL MECHANICAL CONTRACTOR | | | | |
| MECH. | MECHANICAL | | | | |
| MED. MISC. | MEDIUM MISCELLANEOUS | | | | |
| M.O. | MASONRY OPENING | | | | |
| M.T. MTL | METAL THICKNESS METAL | | | | |
| N.I.C. | NOT IN CONTRACT | | | | |
| NO. | NUMBER | | | | |

NO. NOM. N..S.

NUMBER NOMINAL

NOT TO SCALE

| Current Day | Chast Na | Drawing List |
|------------------|-----------|--|
| Current Rev | Sheet No. | Sheet Name |
| ARCHITECTU | RAL | |
| | G100 | Cover Sheet |
| 1 | G101 | Sheet List, Abbreviations and Symbols |
| | G102 | General Notes |
| 1 1 | G103 | First Floor Construction Phasing Plan and Notes |
| 1 | G104 | Second Floor Construction Phasing Plan and Notes |
| ب ¹ ب | G105 | Third Floor Construction Phasing Plan and Notes |
| | G201 | Accessibility Details |
| | D100 | First Floor Demolition Plan |
| | D101 | Second Floor Demolition Plan (Alternate #01) |
| | D102 | Third Floor Demolition Plan (Alternate #02) |
| | A100 | First Floor Plan |
| | A101 | Second Floor Plan (Alternate #01) |
| | A102 | Third Floor Plan (Alternate #02) |
| | A600 | Toilet Rooms - Enlarged Plans and Elevations |
| | A601 | Security Desk and Storage Cubbies Details |
| | A602 | Details |
| | A700 | Interior Elevations |
| | A800 | First Floor Reflected Ceiling Plan |
| | A900 | Schedules and Details |
| | A901 | Finish Schedule |
| | A902 | Finish Schedule |
| | A903 | First Floor Finish Plan |
| | A904 | Second Floor Finish Plan (Alternate #01) |
| | A905 | Third Floor Finish Plan (Alternate #02) |
| | | |
| MECHANICAL | M001 | General Notes, Details, and Schedules |
| | M100 | Partial First and Second Floor HVAC |
| | 191100 | 1 ditial First and Occord Floor FivAo |
| ELECTRICAL | | |
| | E001 | Electrical Legend and Abbreviations |
| | ED101 | Electrical Removals Plan |
| | E101 | Electrical Plan |



Owner: Schenectady County 612 State Street Schenectady, NY 12305

Architect:
C2 Architecture
24 Airport Road
Schenectady, NY 12302

MEP: M.E. Engineering 433 State Street Schenectady, NY 12305

Stamp:

roject:

Interior Renovations to

797 BROADWAY

797 Broadway Schenectady, NY 12305

No. REVISION # DATE:
1 Phasing Plan Addition 08/14/2024

Drawn By: C2 Architecture

Scale: As Noted

Date: 08/12/2024

Job No: 2423

Sheet Title:

SHEET LIST,


ABBREVIATIONS AND

SYMBOLS

Sheet Number:

3101

PLOT DATE: 8/14/2024 11:56:34 AM

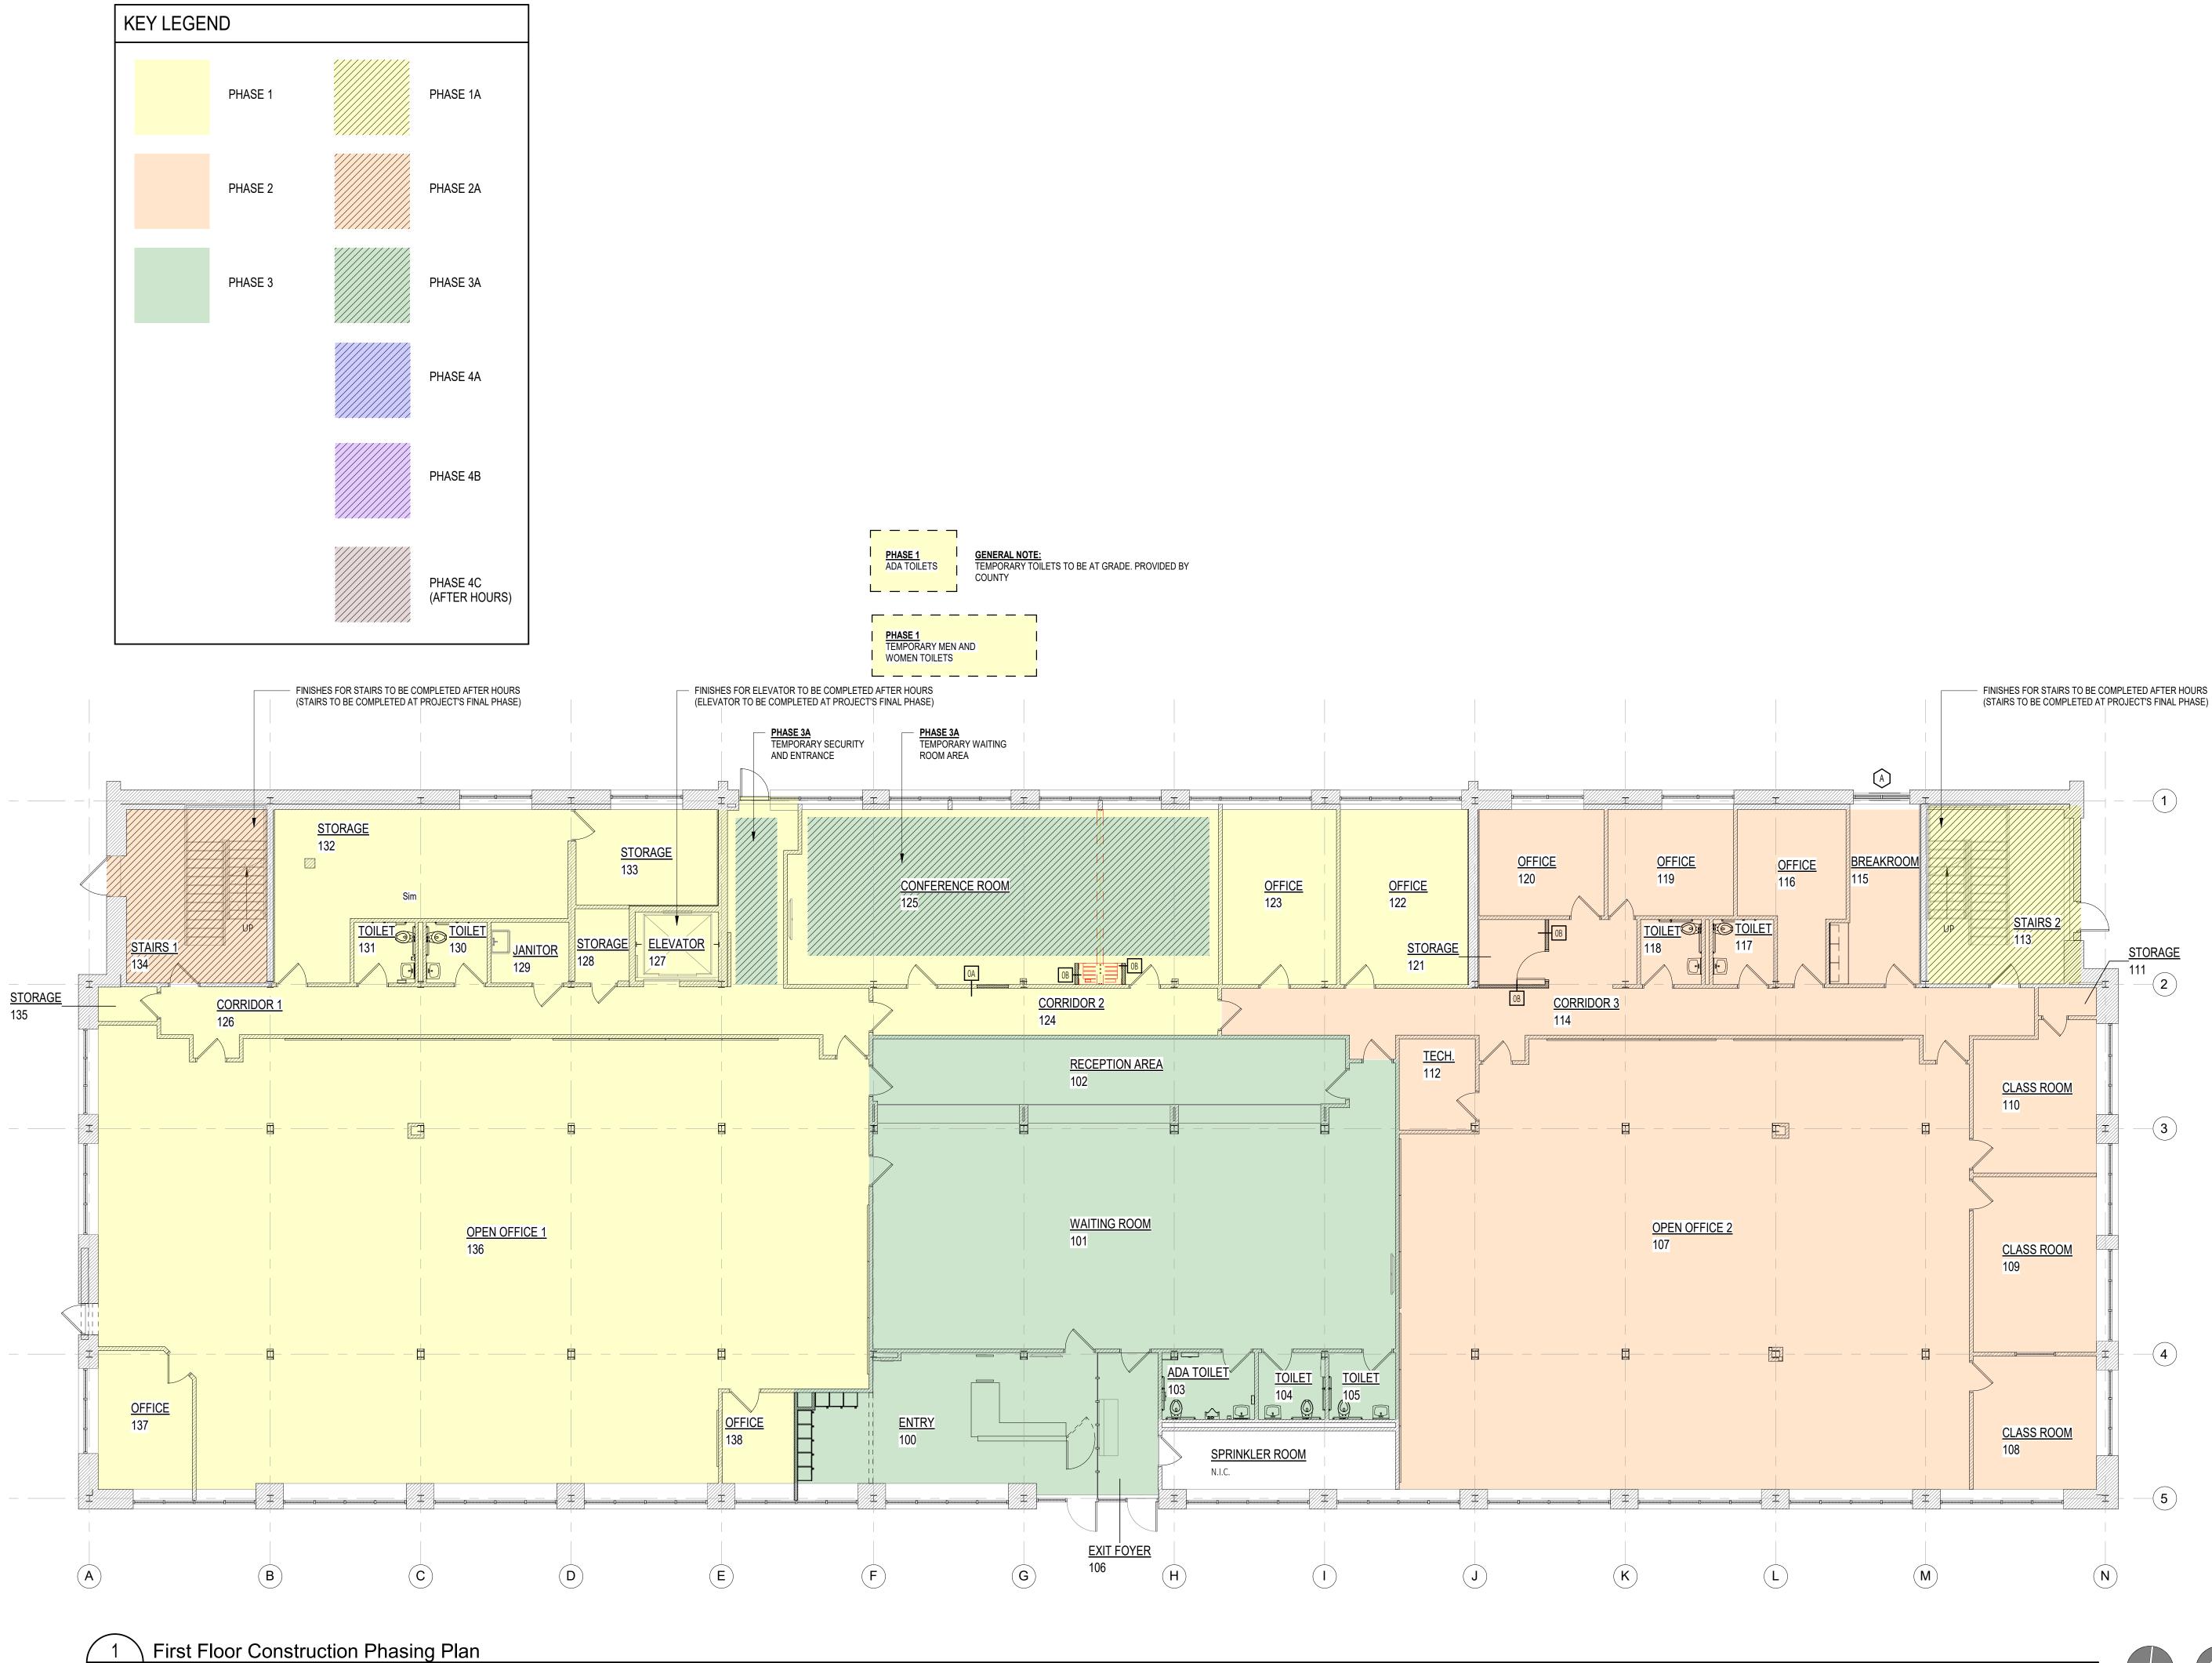

DESIGN GROUP www.C2-DesignGroup.com 24 AIRPORT ROAD SCHENECTADY, NY 12302 518.320.8250

Owner: Schenectady County 612 State Street Schenectady, NY 12305

Architect: C2 Architecture 24 Airport Road Schenectady, NY 12302

M.E. Engineering 433 State Street Schenectady, NY 12305

INTERIOR RENOVATIONS TO

797 BROADWAY

797 Broadway Schenectady, NY 12305


BID SET - RFB 2024-50 REVISION # DATE:
Phasing Plan
Addition 08/14/2024


C2 Architecture Drawn By: 08/12/2024 Job No: Sheet Title: FIRST FLOOR CONSTRUCTION PHASING PLAN AND NOTES

PLOT DATE: 8/14/2024 2:08:55 PM

TRUE NORTH



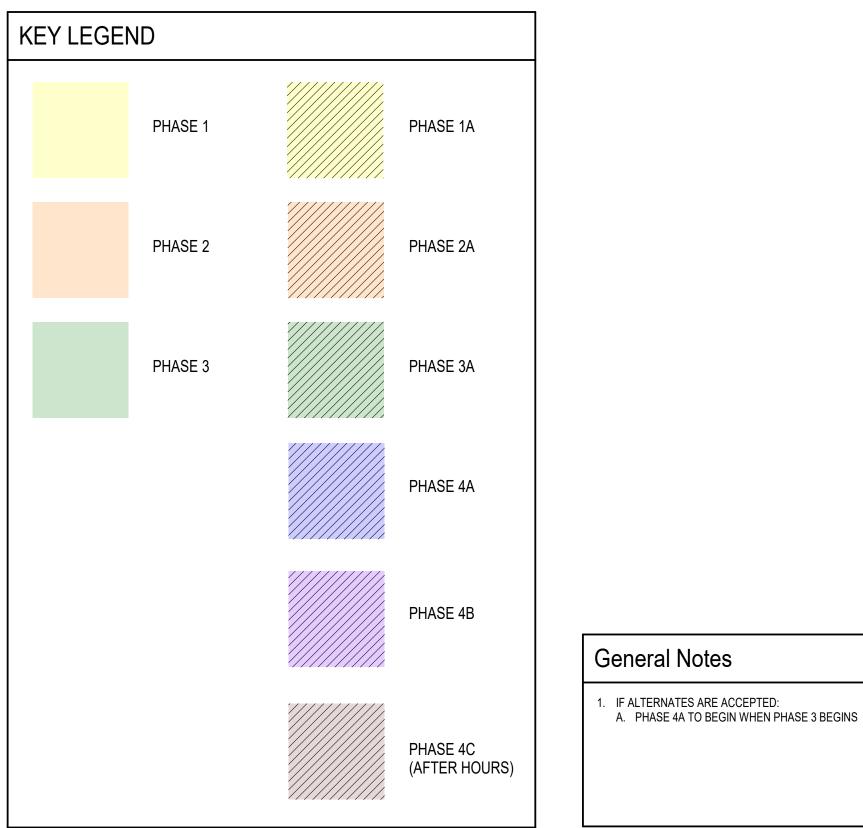

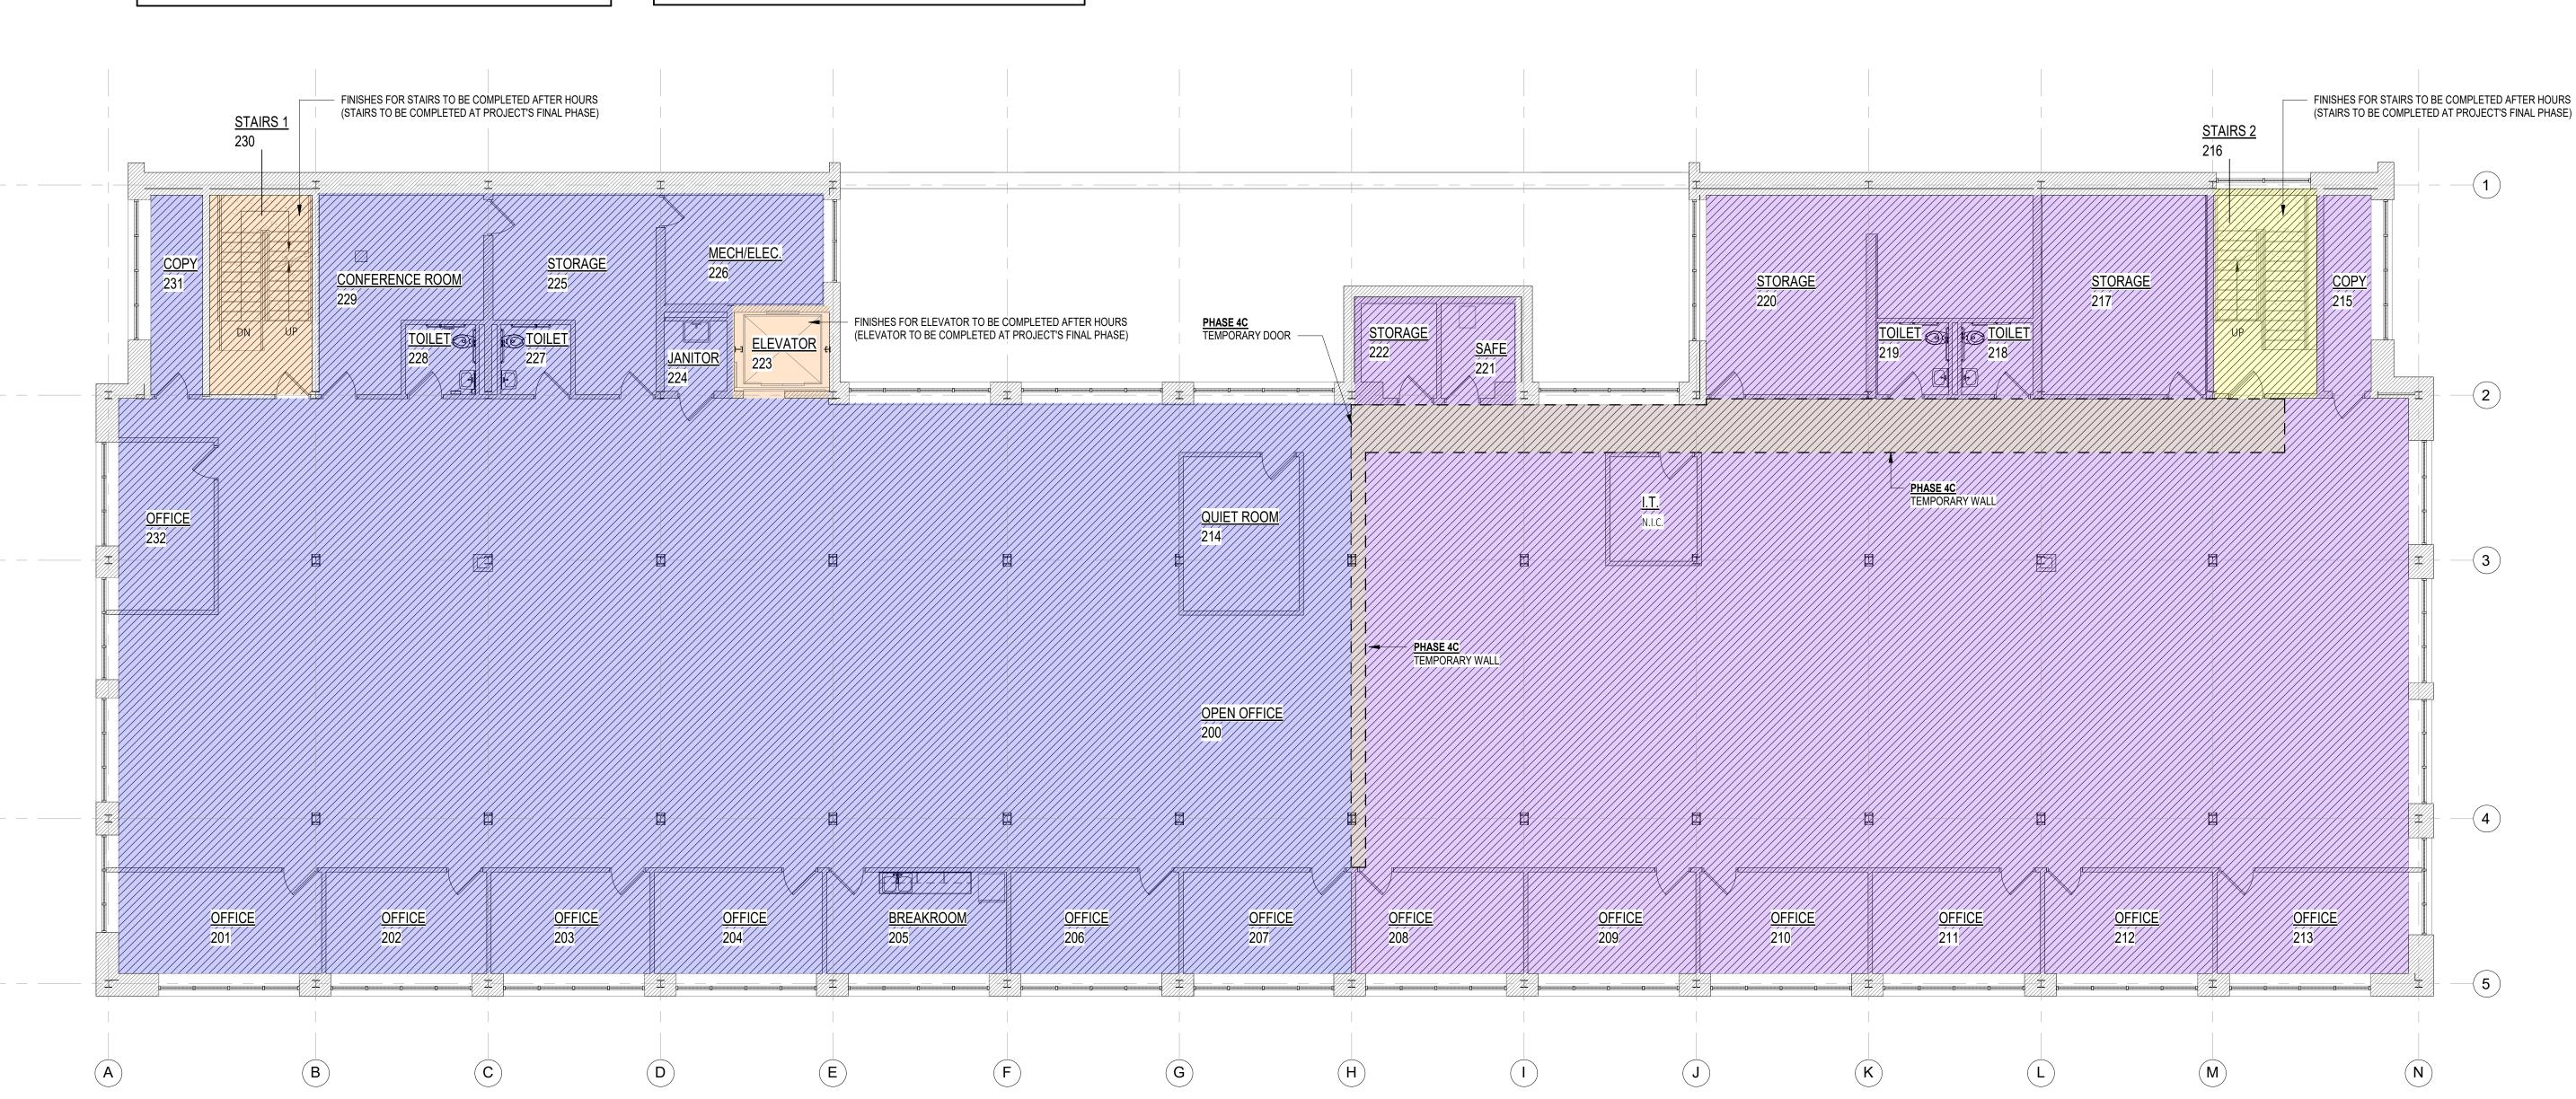

Second Floor Construction Phasing Plan G104 SCALE: 1/8" = 1'-0"





DESIGN GROUP www.C2-DesignGroup.com 24 AIRPORT ROAD SCHENECTADY, NY 12302 518.320.8250

Owner: Schenectady County 612 State Street Schenectady, NY 12305

Architect: C2 Architecture 24 Airport Road Schenectady, NY 12302

M.E. Engineering 433 State Street Schenectady, NY 12305

INTERIOR RENOVATIONS TO


797 BROADWAY

797 Broadway Schenectady, NY 12305

BID SET - RFB 2024-50 REVISION # DATE:
Phasing Plan
Addition 08/14/2024

C2 Architecture Drawn By: 08/12/2024 Job No: Sheet Title: SECOND FLOOR CONSTRUCTION PHASING PLAN AND NOTES {G104}

PLOT DATE: 8/14/2024 11:56:36 AM

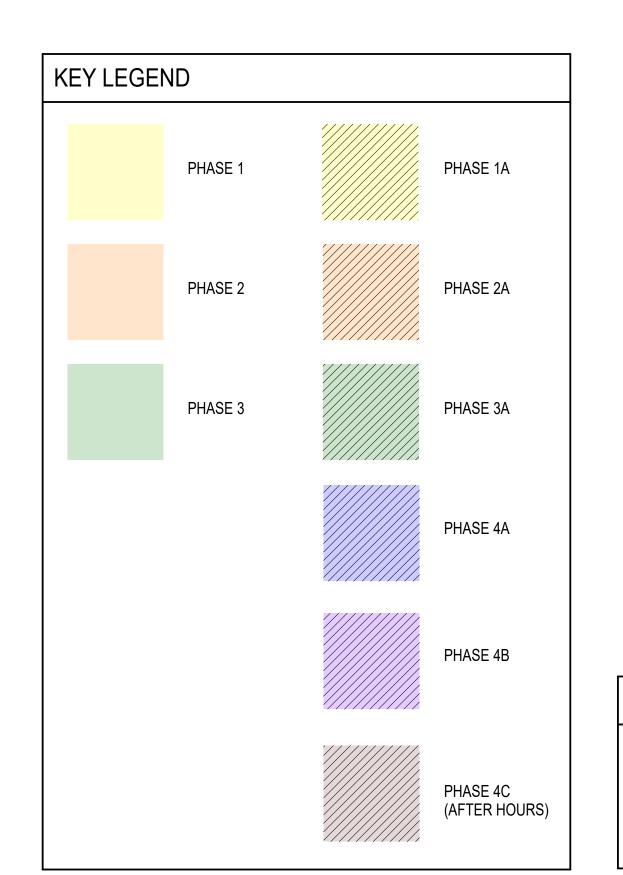

FINISHES FOR STAIRS TO BE COMPLETED AFTER HOURS

(STAIRS TO BE COMPLETED AT PROJECT'S FINAL PHASE)

<u>I.T. DEPT.</u> 330

STORAGE

//320///

<u>OFFICE</u> 329

STORAGE 323

OFFICE 324

OFFICE 325

OFFICE 326

General Notes . IF ALTERNATES ARE ACCEPTED: A. PHASE 4A TO BEGIN WHEN PHASE 3 BEGINS

MÉCH/ÉLÉC.

CORRIDOR 1/315

CONFERENCE ROOM
3333

ELEVATOR

DESIGN GROUP www.C2-DesignGroup.com 24 AIRPORT ROAD SCHENECTADY, NY 12302 518.320.8250

Owner: Schenectady County 612 State Street Schenectady, NY 12305

Architect: C2 Architecture 24 Airport Road Schenectady, NY 12302

M.E. Engineering 433 State Street Schenectady, NY 12305

INTERIOR RENOVATIONS TO

BID SET - RFB 2024-50 REVISION # DATE: Phasing Plan 08/14/2024 Addition

797 BROADWAY

797 Broadway Schenectady, NY 12305

C2 Architecture Drawn By: 08/12/2024 Job No: Sheet Title: THIRD FLOOR CONSTRUCTION PHASING PLAN AND NOTES

PLOT DATE: 8/14/2024 11:56:37 AM

OFFICE 337 OFFICE 301 OFFICE 327 OFFICE 334 <u>OFFICE</u> 335 OFFICE 336 OFFICE 331 <u>OFFICE</u> //328/// B **(C)** D E F G H K Third Floor Construction Phasing Plan

SPECIAL INVESTIGATION

FINISHES FOR ELEVATOR TO BE COMPLETED AFTER HOURS (ELEVATOR TO BE COMPLETED AT PROJECT'S FINAL PHASE)

YOUTH SERVICES



N

4

FINISHES FOR STAIRS TO BE COMPLETED AFTER HOURS

(STAIRS TO BE COMPLETED AT PROJECT'S FINAL PHASE)

MOTHER'S ROOM

309

COMMISSIONER OFFICE

BRANDY'S OFFICE

BREAKROOM

OFFICE 307

L

CONFERENCE ROOM


M

STORAGE

/312///

STORAGE 304

/311//

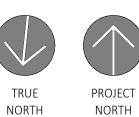

797 Broadway - Addendum #2 Insert

Revised/New Contract Drawings and Specifications

1. Specification 087100, *Door Hardware:*Section 3.9: **Delete** Hardware Group Number 02 and replace with the following:

Hardware Group Number 02

For use on Door 102:

Provide each SGL door(s) with the following:

| QTY | | DESCRIPTION | CATALOG NUMBER | | FINISH | MFR |
|-----|-----|----------------------|--------------------|---|-----------|-----|
| 1 | EA | CONT. HINGE | SL-11 | | ALUM. | SEL |
| 1 | EA | ELECTRIC STRIKE | 9600 | | 630 | HES |
| 1 | EA | PANIC DEVICE | ED9700 x MKS-09-RS | | 630/626 | TOW |
| 1 | EA | MORTISE CYLINDER | 40561 | | 626 | TOW |
| 1 | EA | PERM. CORE | BY OWNER | | | |
| 1 | EA | LOCK GUARD | LG0 | | ALU4056IM | SEL |
| 1 | EA | POWER OPERATOR | 1800 | | ALUM | REC |
| 2 | EA | ADA ACUATOR | Re-use exist. | | | |
| 1 | EA | WALL STOP | WS406/407CVX | | 630 | IVE |
| 1 | SET | GASKETING | 429AA-S | | AA | ZER |
| 1 | EA | DOOR SWEEP | 8198AA | | AA | ZER |
| 1 | EA | THRESHOLD | 626A-223 | | Α | ZER |
| 1 | EA | CARD READER | EXISTING TO REMAIN | × | BLK | |
| 1 | EA | DOOR POSITION SWITCH | BY SECURITY VENDOR | N | | |
| 1 | EA | POWER SUPPLY | BY SECURITY VENDOR | N | | |

THEORY OF OPERATION:

- -Door normally locked.
- -Valid credential to reader energizes electric strike to allow entry.
- -Free egress at all times.
- -Door remains locked upon loss of power (fail secure).

| Abbreviation | Name |
|--------------|--------------------------------------|
| ABH | Architectural Builders Hardware Mfg. |
| BOW | By Owner |
| GLY | Glynn-Johnson Corp |
| IVE | H.B. Ives |
| KNC | K.N. Crowder Mfg. Inc. |
| PBB | PBB Inc |
| REC | Record Group/ASSA-ABLOY |
| SEL | Select Products Ltd |
| SPL | Special-Lite Inc. |
| TST | Town Steel Inc. |

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C2 Project Number 2423.00

SECTION 09 84 00 SOUND-ABSORBING PANELS

PART 1 - GENERAL

1.01 SECTION INCLUDES

A. Acoustic Wall Panels.

1.02 RELATED SECTIONS

A. Section 09

1.03 REFERENCES

- A. ASTM C423 Standard Test Method for Sound Absorption and Sound Absorption Coefficients by the Reverberation Room Method; 2009a.
- B. ASTM E84 Standard Test Method for Surface Burning Characteristics of Building Materials; 2016.
- C. ASTM E795 Standard Practices for Mounting Test Specimens During Sound Absorption Tests; 2016.

1.04 SUBMITTALS

- A. General: Submit manufacturer's documentation for each type of product under provisions of Section 01 30 30 Administrative Requirements, for submittal procedures.
- B. Product Data: Manufacturer's printed data sheets for products specified.
- C. Shop Drawings: Fabrication and installation details, panel layout.
- Selection Samples: Manufacturer's color charts for applicable material, indicating full range of material, colors, and patterns available.
- E. Verification Samples: Fabricated samples of each type of product specified; 6" minimum length and width, showing construction, edge details.
- F. Test Reports: Certified test data from an independent test agency verifying that panels meet specified requirements for acoustical and fire performance.
- G. Maintenance Materials: Furnish maintenance information and recommendations for Owners use.

1.05 QUALITY ASSURANCE

- A. Source Limitations: All similar products to be obtained from a single manufacturer through one source providing a comprehensive material and installation package.
- B. Installer Qualifications: Utilization of an installer with demonstrated experience and quality in projects of similar size and complexity.

1.06 DELIVERY, STORAGE, AND HANDLING

- A. Protect acoustical units from moisture during shipment, storage, and handling. Deliver in factory-wrapped bundles; do not open bundles until units are needed for installation. Ensure all supplied hardware, material, and components are maintained until product is fully installed.
- B. Store units flat, in dry, well-ventilated space; do not stand on end.
- C. Protect edges from damage.
- D. Acclimatize product for minimum 24 hours at temperature and humidity approximately that of occupancy prior to installation.

1.07 PROJECT CONDITIONS

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C2 Project Number 2423.00

- A. Environmental Limitations: Do not deliver or install materials until spaces are enclosed from the exterior environment, wet work in spaces is complete and dry, and HVAC system is maintaining an ambient temperature at occupancy levels during the remainder of the construction period.
- B. Field Measurements: Installer to verify field measurements and dimensions as indicated in Design Submittal.
 - 1. Coordinate location of other product and trades with product layout.
- C. Ensure that Design Submittal signoffs and other required information are supplied in time to prevent interruption of construction process. Ensure that products of this section are supplied to affected trades in time to prevent interruptions.

1.08 WARRANTY

 A. Special Warranty: Refer to manufacturer's standard warranty for specific products, terms, and limitations.

PART 2 - PRODUCTS

2.01 MANUFACTURER

- A. Acceptable Manufacturer: TURF; Located at 41 Prairie Parkway, Gilberts, IL 60136; Phone: 844.TURF.OMG (844.887.3664); Email: hello@turf.design; Web: www.turf.design
- B. Or Architect approved equal.

2.02 SOUND-ABSORBING AND SOUND-DIFFUSING PANELS

- A. Basis of Design:
 - 1. Turf Design; Product: 'Wall Tile' https://turf.design/
- B. Material Minimum Performance Attributes:
 - 1. Surface Burning Characteristics: Flame spread index of 25 or less and smoke developed index of 450 or less, when tested in accordance with ASTM E84.
 - 2. UL Tested ASTM E-84: Class A
 - 3. Noise Reduction Coefficient (NRC):
 - a. Tested in accordance with ASTM C423 for Type A mounting, per ASTM E795. b.9MM Panel: Average NRC > 0.25
- C. Product Attributes:
 - 1. Tile Size: As indicated in Submittal Drawings / Product Order Form and per Architects approval.
 - 2. Tile Thickness: 9 mm. laminated.
 - 3. Edges: Exposed felt, machined edge.
 - 4. Corners: Square, exposed felt, machined edge.
 - 5. Material: Polyester (PET) felt, 60% pre-consumer recycled
 - 6. Color: As selected by Architect from manufacturer's full range.
 - 7. Patterns: As selected by Architect from manufacturer's full range and outlined in Submittal Drawings.
 - 8. Mounting Method:
 - a. Factory applied adhesive backing.
 - b.Installer applied adhesive to non-adhesive back tile.

2.03 FABRICATION

- A. General: CNC fabricate panels to sizes, configurations and patterns on 9 mm.
- B. Tolerances: Fabricate to finished tolerance of plus or minus 1/16 inch for thickness, overall length and width, and square-ness from corner to corner.

2.04 ACCESSORIES

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A. Wall Mounting Accessories: Manufacturer's standard accessories at locations indicated on each acoustical unit, sized appropriately for weight of acoustical unit.

PART 3 - EXECUTION

3.01 EXAMINATION

A. Examine substrates for conditions detrimental to installation of acoustical units. Proceed with installation only after unsatisfactory conditions have been corrected.

3.02 INSTALLATION

- A. Install acoustical units in locations indicated, following manufacturer's installation instructions and in accordance with local jurisdiction authorities.
- B. Wall surface to be smooth, cleaned, and dry prior to installation of adhesive tile product.
- C. Directly adhere to tile to wall surface with factory applied adhesive or installer applied construction adhesive non adhesive tiles.
- D. Align panels accurately, with edges plumb and edges level. Scribe to fit accurately at adjoining work and penetrations.
- E. Install acoustical units to construction tolerances of plus or minus 1/16 inch for the following:
 - 1. Plumb and level.
 - 2. Flatness.
 - 3. Width of joints.

3.03 CLEANING

- A. Clean felt facing upon completion of installation from dust and other foreign materials, following manufacturer's instructions.
- B. Vacuum occasionally to remove any particulate matter and air-borne debris or dust. Compressed air can be used to dust the material in difficult to reach areas or for large assemblies.

3.04 PROTECTION

- A. Provide protection of installed acoustical panels until completion of the work.
- B. Replace panels that cannot be cleaned and repaired to satisfaction of the Architect.

END OF SECTION 09 84 00